#### **EXISTING PLAN SYMBOLS**

#### **EXISTING UTILITY SYMBOLS**

_,	
FIBER OPTIC LINE	—— F —
GAS LINE	——— G ——
COMMUNICATION LINE	—— с —
ELECTRIC POWER LINE	—— Е ——
WATER MAIN	II-
SANITARY SEWER	>
STORM SEWER	
COMMUNICATIONS PEDESTAL	
POWER POLE	ø
ELECTRIC BOX	E
CATCH BASIN	
STORM APRON	D
STORM SEWER MANHOLE	60
GATE VALVE	×
HYDRANT	-6-
SANITARY SEWER MANHOLE	s


#### EXCAVATION NOTICE SYSTEM

A CALL TO GOPHER STATE ONE (651-454-0002) IS REQUIRED A MINIMUM OF 48 HOURS PRIOR TO PERFORMING ANY EXCAVATION.




### 2022 POND MAINTENANCE PROJECT

## CITY OF CHANHASSEN, MN CITY PROJECT NO. 22-05

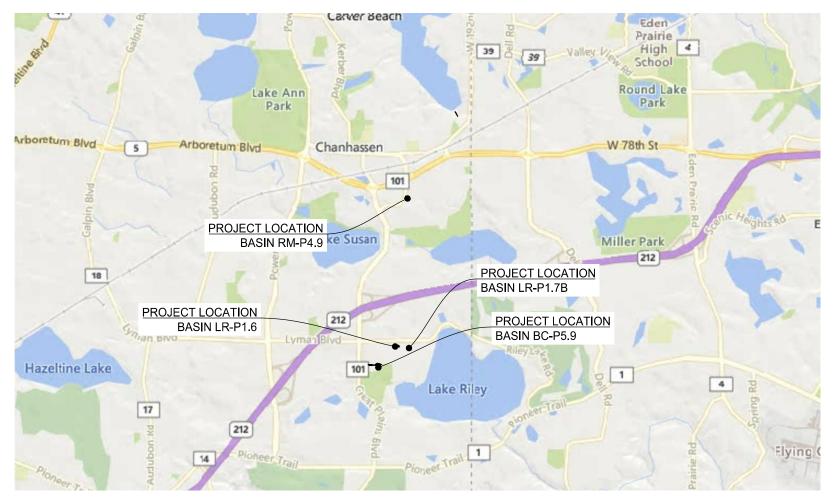

PROJECT LOCATION MAP

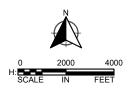

#### UTILITY INFORMATION

THE SUBSURFACE UTILITY INFORMATION IN THIS PLAN IS UTILITY QUALITY LEVEL D. THIS UTILITY QUALITY LEVEL WAS DETERMINED ACCORDING TO THE GUIDELINES OF CI/ASCE 38-02, ENTITLED "STANDARD GUIDELINES FOR THE COLLECTION AND DEPICTION OF EXISTING SUBSURFACE UTILITY DATA."

GOPHER ONE CALL TICKET NUMBER: 223001257, 223001402, 223001468, 223001568, 223001622, 223001837

PLAN REVISIONS			
DATE	SHEET NO.	APPROVED BY	

#### GOVERNING SPECIFICATIONS

THE 2020 EDITION OF THE MINNESOTA DEPARTMENT OF TRANSPORTATION "STANDARD SPECIFICATIONS FOR CONSTRUCTION" AND THE 2022 CITY OF CHANHASSEN STANDARD SPECIFICATIONS AND DETAIL PLATES SHALL GOVERN.

ALL TRAFFIC CONTROL DEVICES SHALL CONFORM TO THE LATEST EDITION OF THE MINNESOTA MANUAL ON UNIFORM TRAFFIC CONTROL DEVICES, INCLUDING THE LATEST FIELD MANUAL FOR TEMPORARY TRAFFIC CONTROL ZONE LAYOUTS.

#### PLAN SET INDEX

SHEET NO.	SHEET TITLE
1	TITLE SHEET
2	REMOVAL PLANS
3,5-7	GRADING PLANS
4	BASIN BC-P5.9 ACCESS
8-11	EROSION CONTROL PLANS
12	MISCELLANEOUS DETAILS



THIS PLAN SET CONTAINS 12 SHEETS

THIS PLAN SET HAS BEEN PREPARED FOR:

CITY OF CHANHASSEN 7700 MARKET BOULEVARD CHANHASEN, MN 55317 (952) 227-1100

ALL APPLICABLE FEDERAL, STATE, AND LOCAL LAWS AND ORDINANCES WILL BE COMPLIED WITH IN THE CONSTRUCTION OF THIS PROJECT.



I HEREBY CERTIFY THAT THIS PLAN WAS PREPARED BY ME OR UNDER MY DIRECT SUPERVISION, AND THAT I AM A DULY LICENSED PROFESSIONAL ENGINEER UNDER THE LAWS OF THE STATE OF MINNESOTA.

William C. ala


WILLIAW ALWS, P.E

DATE: <u>11/22/2022</u>

LICENSE NUMBER: 54301

SHEET 1196-000 1 05 0F 12

WSB PROJ. NO. 021196-000 CITY PROJ. NO. 22-05

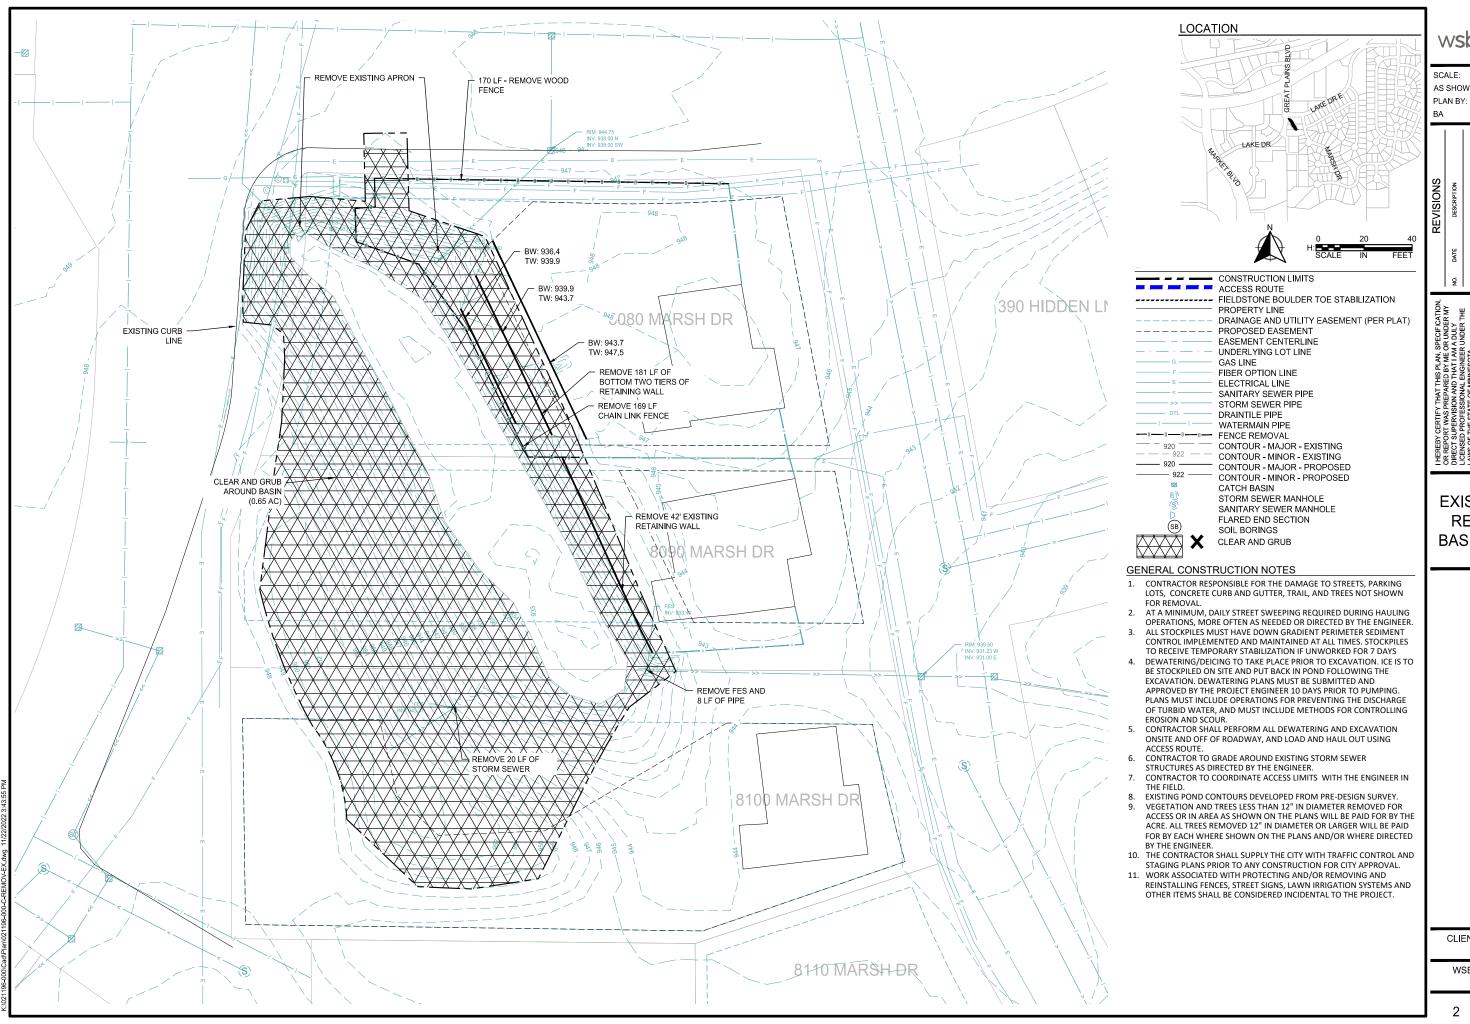





AS SHOWN CHECK BY: KJF

**EXISTING AND** 


**REMOVALS** BASIN RM-P4.9


> 2022 POND MAINTENANCE PROJECT CITY OF CHANHASSEN, MN

CLIENT PROJECT NO.

WSB PROJECT NO. 021196-000

SHEET

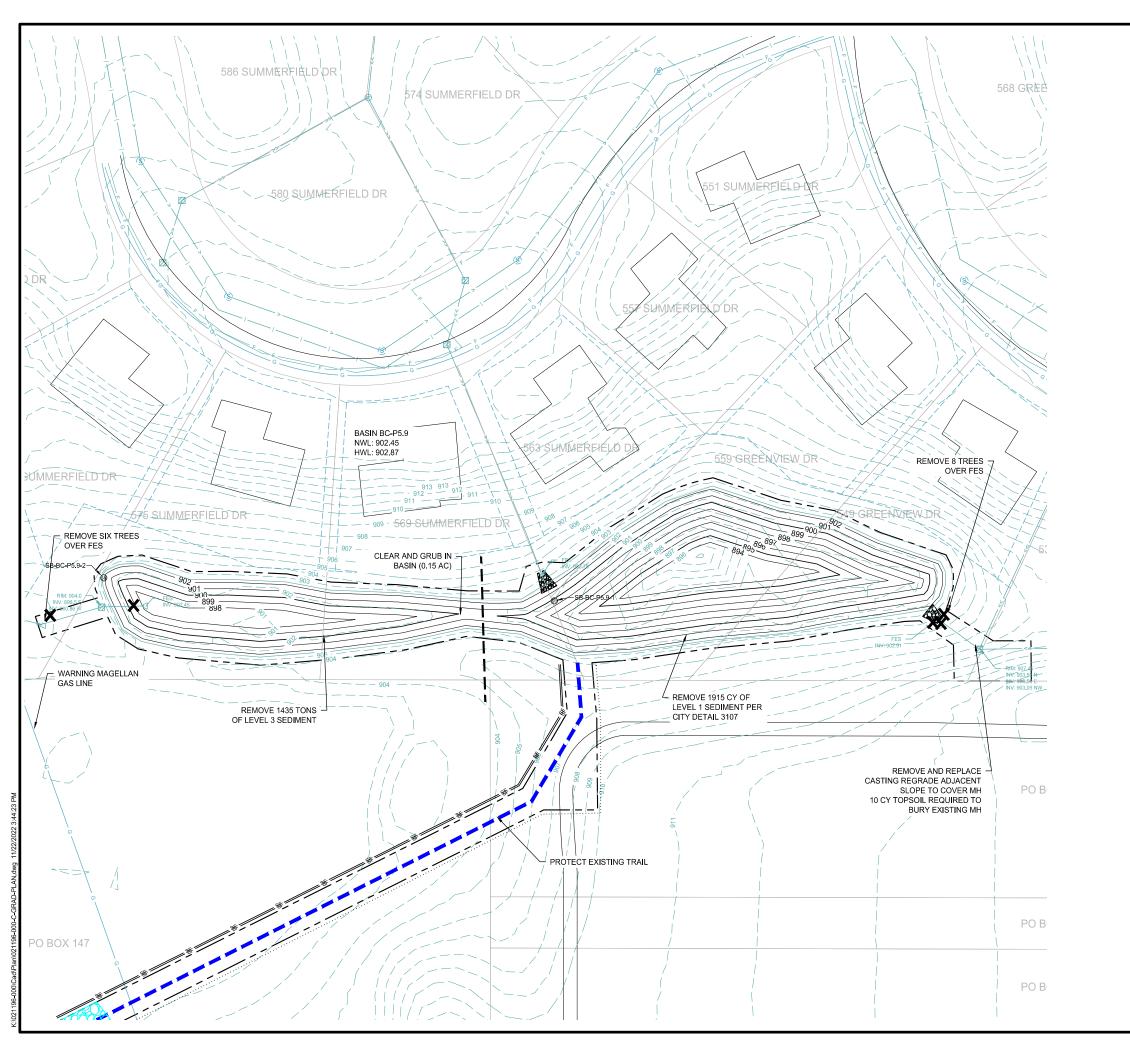

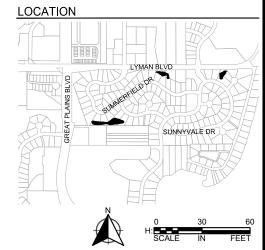

CONSTRUCTION LIMITS
ACCESS ROUTE
FIELDSTONE BOULDER TOE STABILIZATION PROPERTY LINE DRAINAGE AND UTILITY EASEMENT (PER PLAT) PROPOSED EASEMENT EASEMENT CENTERLINE UNDERLYING LOT LINE GAS LINE FIBER OPTION LINE ELECTRICAL LINE SANITARY SEWER PIPE STORM SEWER PIPE DRAINTILE PIPE WATERMAIN PIPE FENCE REMOVAL 920 CONTOUR - MAJOR - EXISTING CONTOUR - MINOR - EXISTING ----- 920 ---CONTOUR - MAJOR - PROPOSED - 922 CONTOUR - MINOR - PROPOSED CATCH BASIN STORM SEWER MANHOLE SANITARY SEWER MANHOLE FLARED END SECTION SOIL BORINGS CLEAR AND GRUB

#### **GENERAL CONSTRUCTION NOTES**

- CONTRACTOR RESPONSIBLE FOR THE DAMAGE TO STREETS, PARKING LOTS, CONCRETE CURB AND GUTTER, TRAIL, AND TREES NOT SHOWN FOR REMOVAL.
- AT A MINIMUM, DAILY STREET SWEEPING REQUIRED DURING HAULING OPERATIONS, MORE OFTEN AS NEEDED OR DIRECTED BY THE ENGINEER.
- ALL STOCKPILES MUST HAVE DOWN GRADIENT PERIMETER SEDIMENT CONTROL IMPLEMENTED AND MAINTAINED AT ALL TIMES. STOCKPILES TO RECEIVE TEMPORARY STABILIZATION IF UNWORKED FOR 7 DAYS
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SCALE:

AS SHOWN

PLAN BY:



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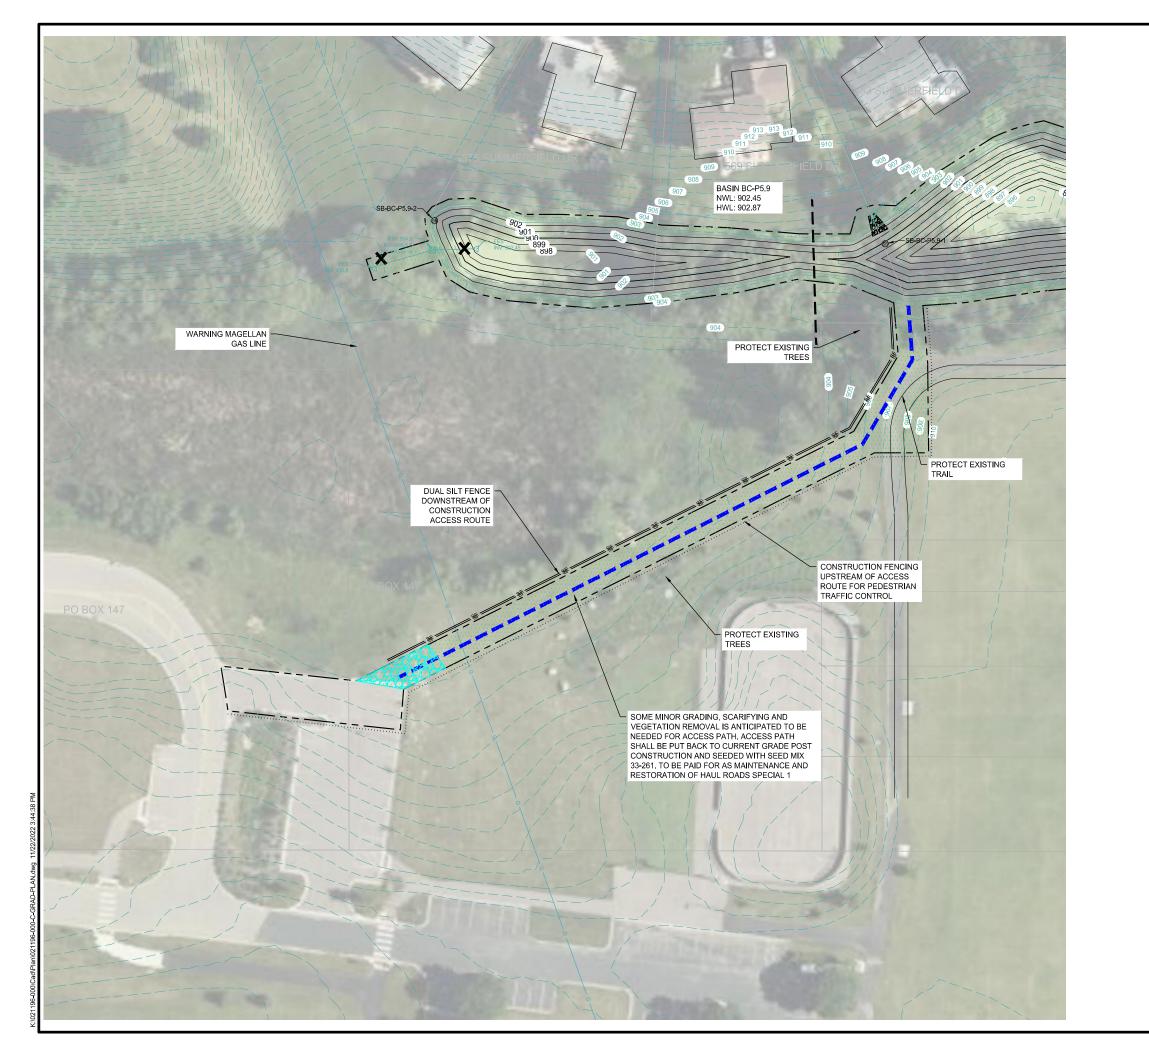
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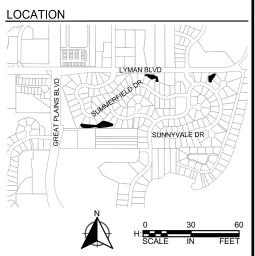
**GRAD PLAN** BASIN BC-P5.9

> 2022 POND MAINTENANCE PROJECT CITY OF CHANHASSEN, MN

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CONSTRUCTION LIMITS
ACCESS ROUTE
FIELDSTONE BOULDER TOE STABILIZATION PROPERTY LINE

DRAINAGE AND UTILITY EASEMENT (PER PLAT)

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EASEMENT CENTERLINE

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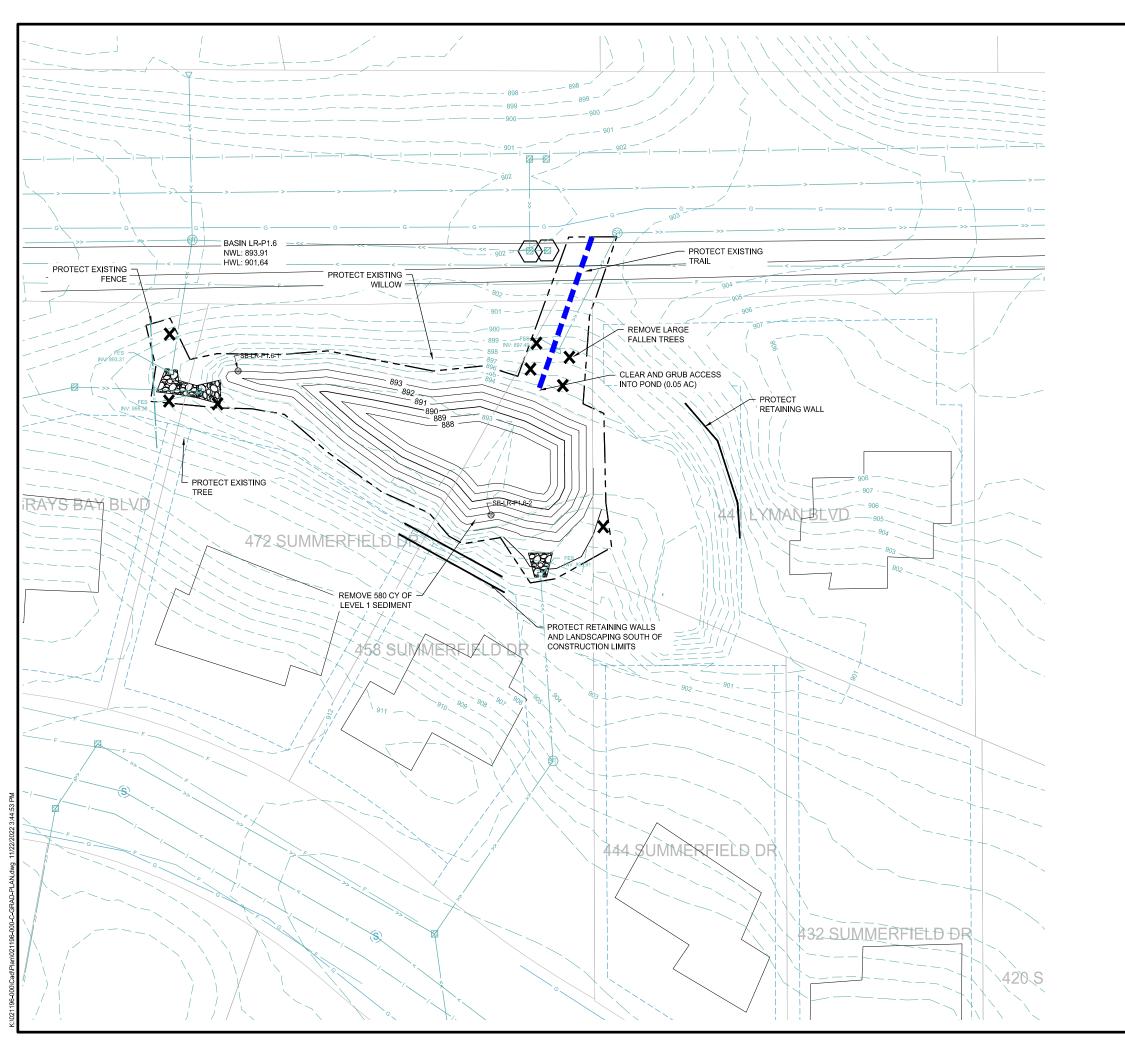
SCALE: AS SHOWN SML PLAN BY: CHECK BY: KJF


**GRAD PLAN BASIN BC-P5.9 ACCESS** 

> 2022 POND MAINTENANCE PROJECT CITY OF CHANHASSEN, MN

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SCALE: AS SHOWN

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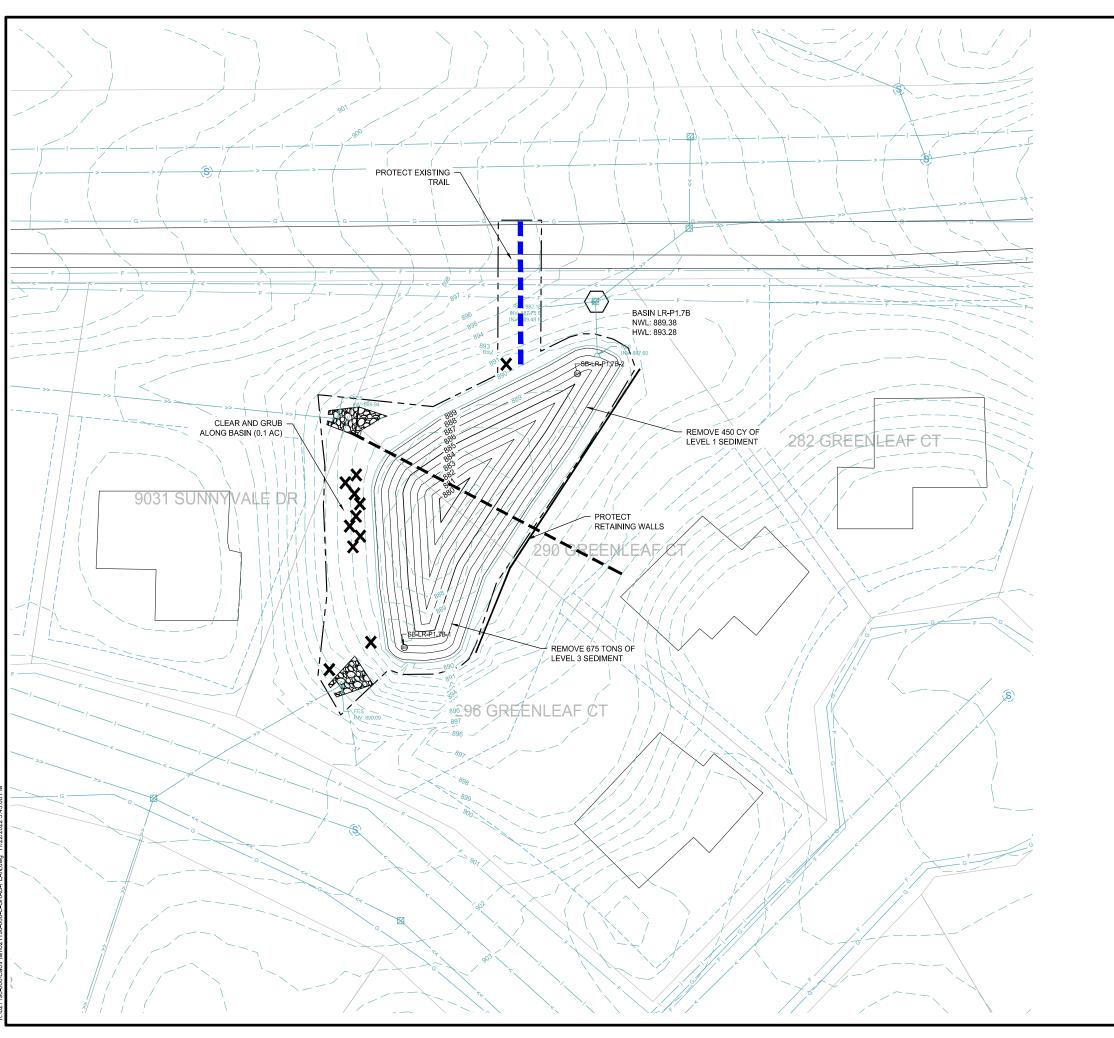
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**GRAD PLAN** BASIN LR-P1.6


> 2022 POND MAINTENANCE PROJECT CITY OF CHANHASSEN, MN
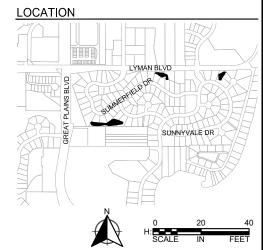
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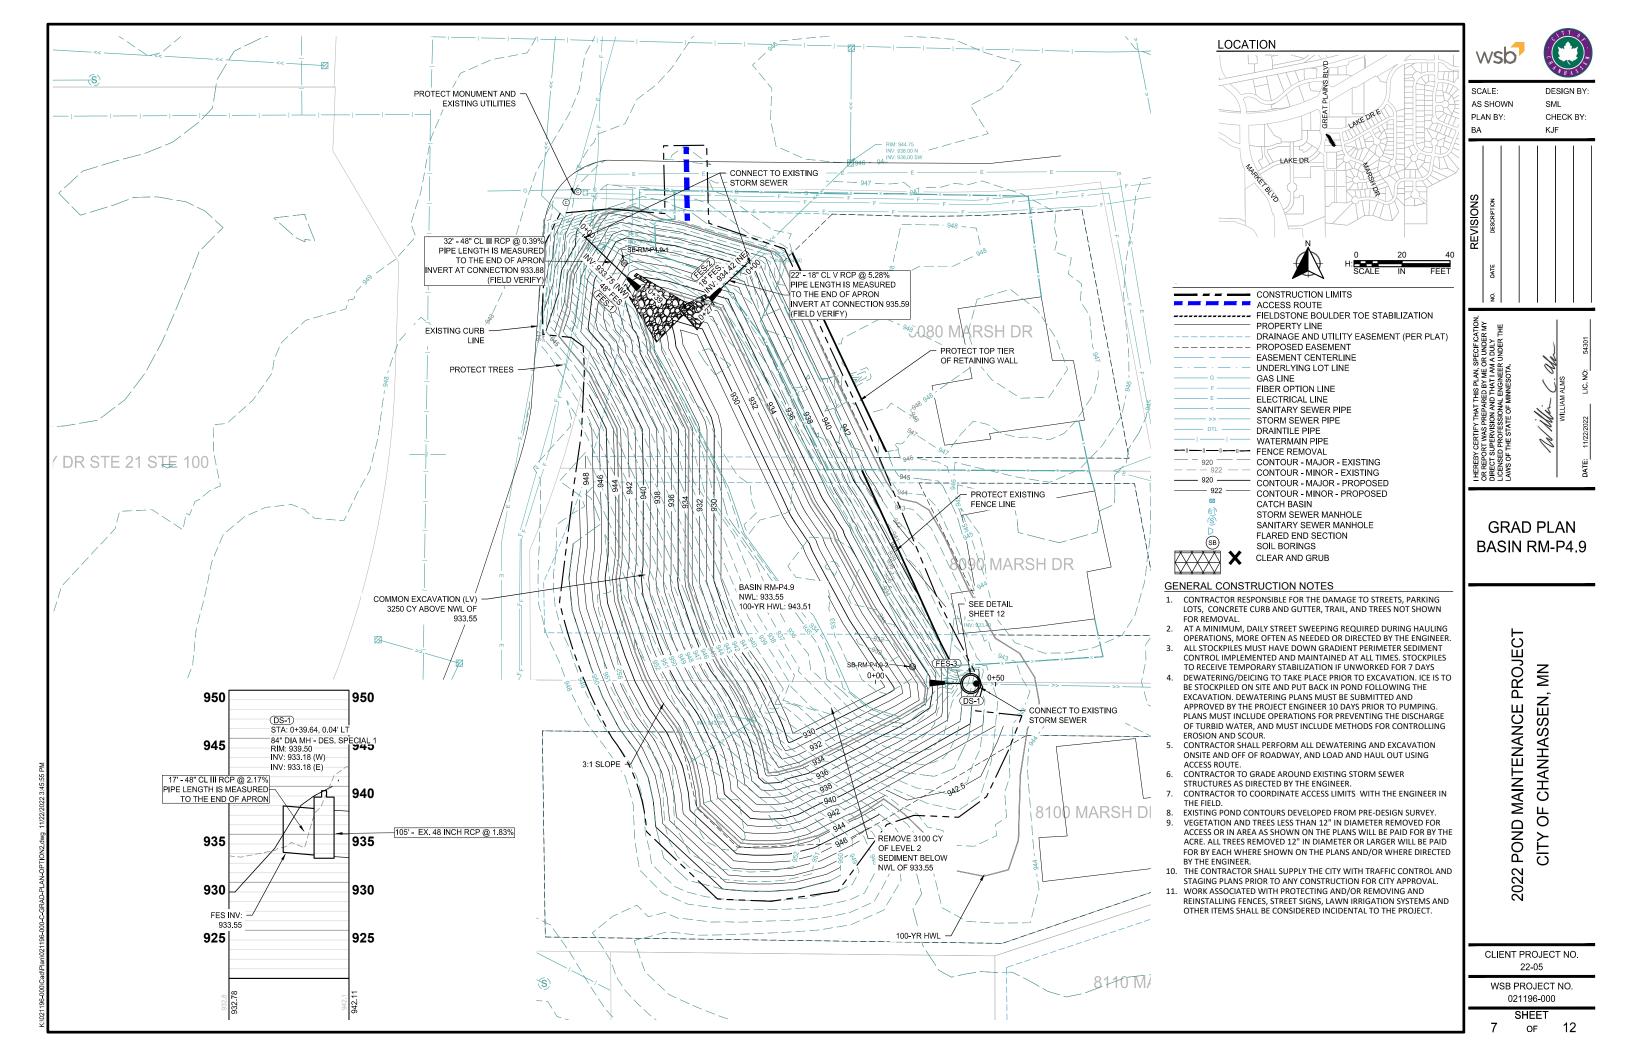
**GRAD PLAN** BASIN LR-P1.7B


> 2022 POND MAINTENANCE PROJECT CITY OF CHANHASSEN, MN

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SHEET



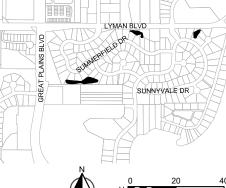

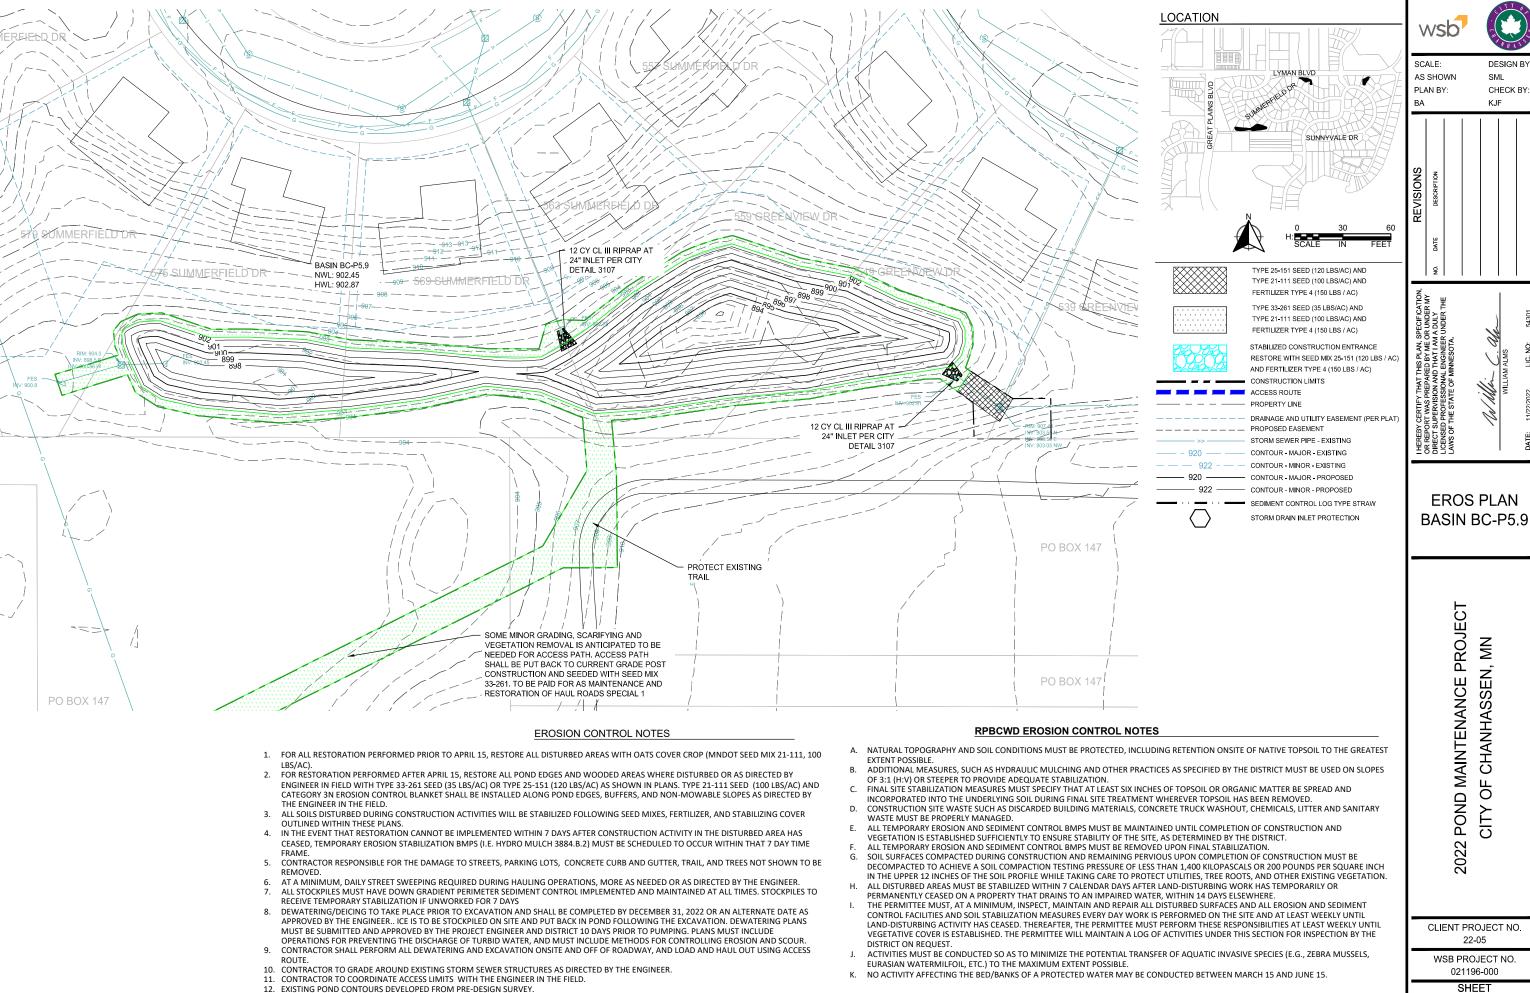


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22-05 WSB PROJECT NO.

CITY OF CHANHASSEN, MN

021196-000



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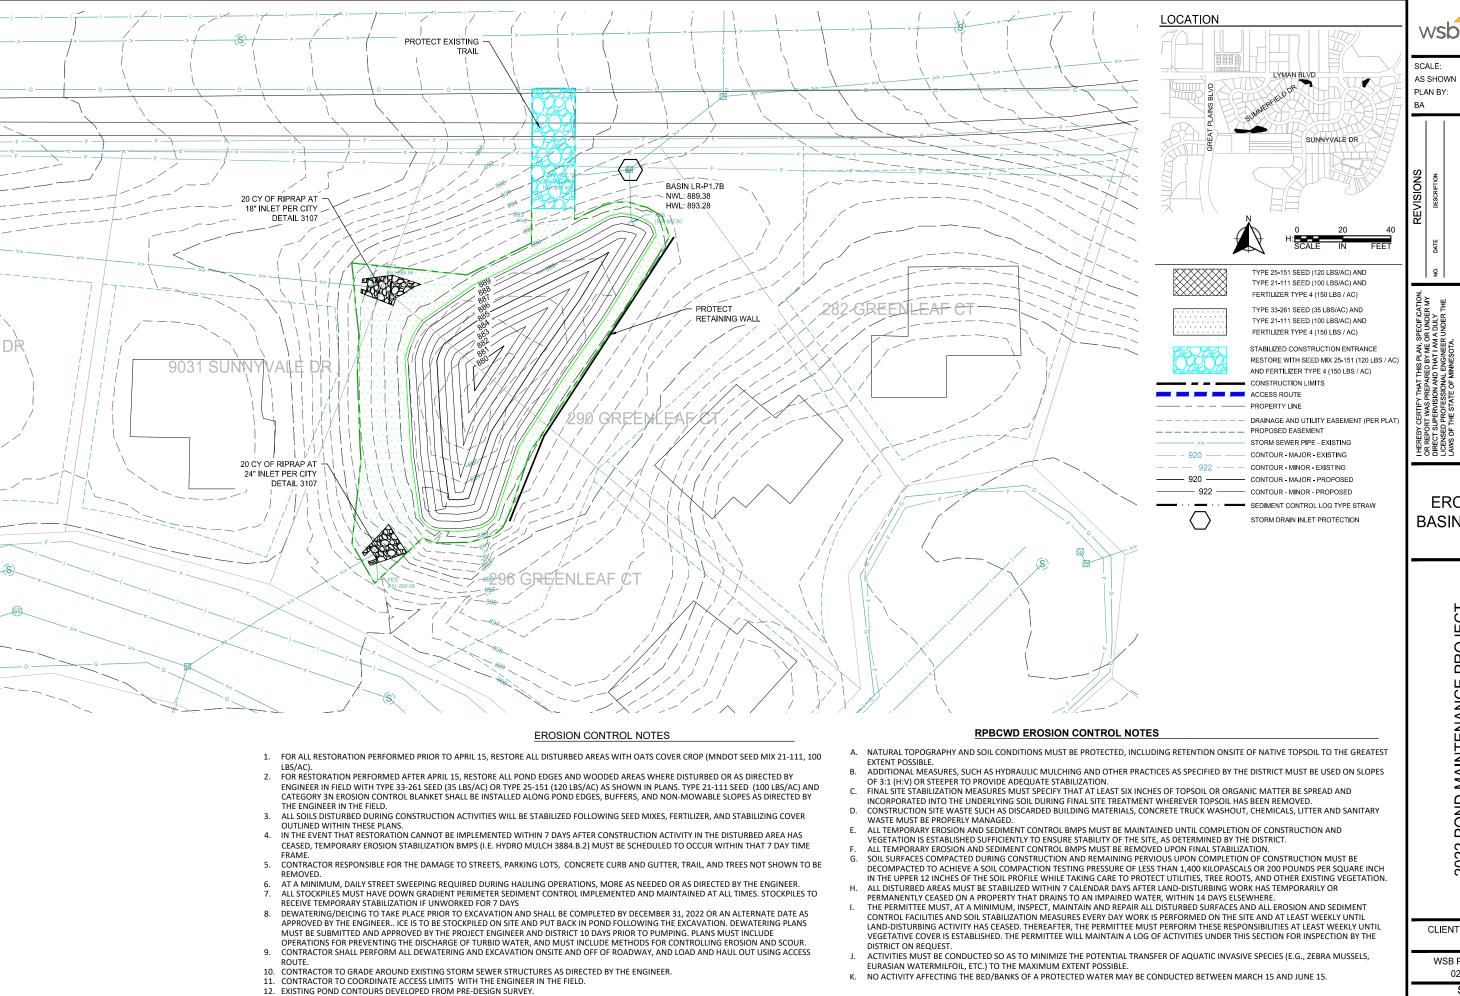
**EROS PLAN** 

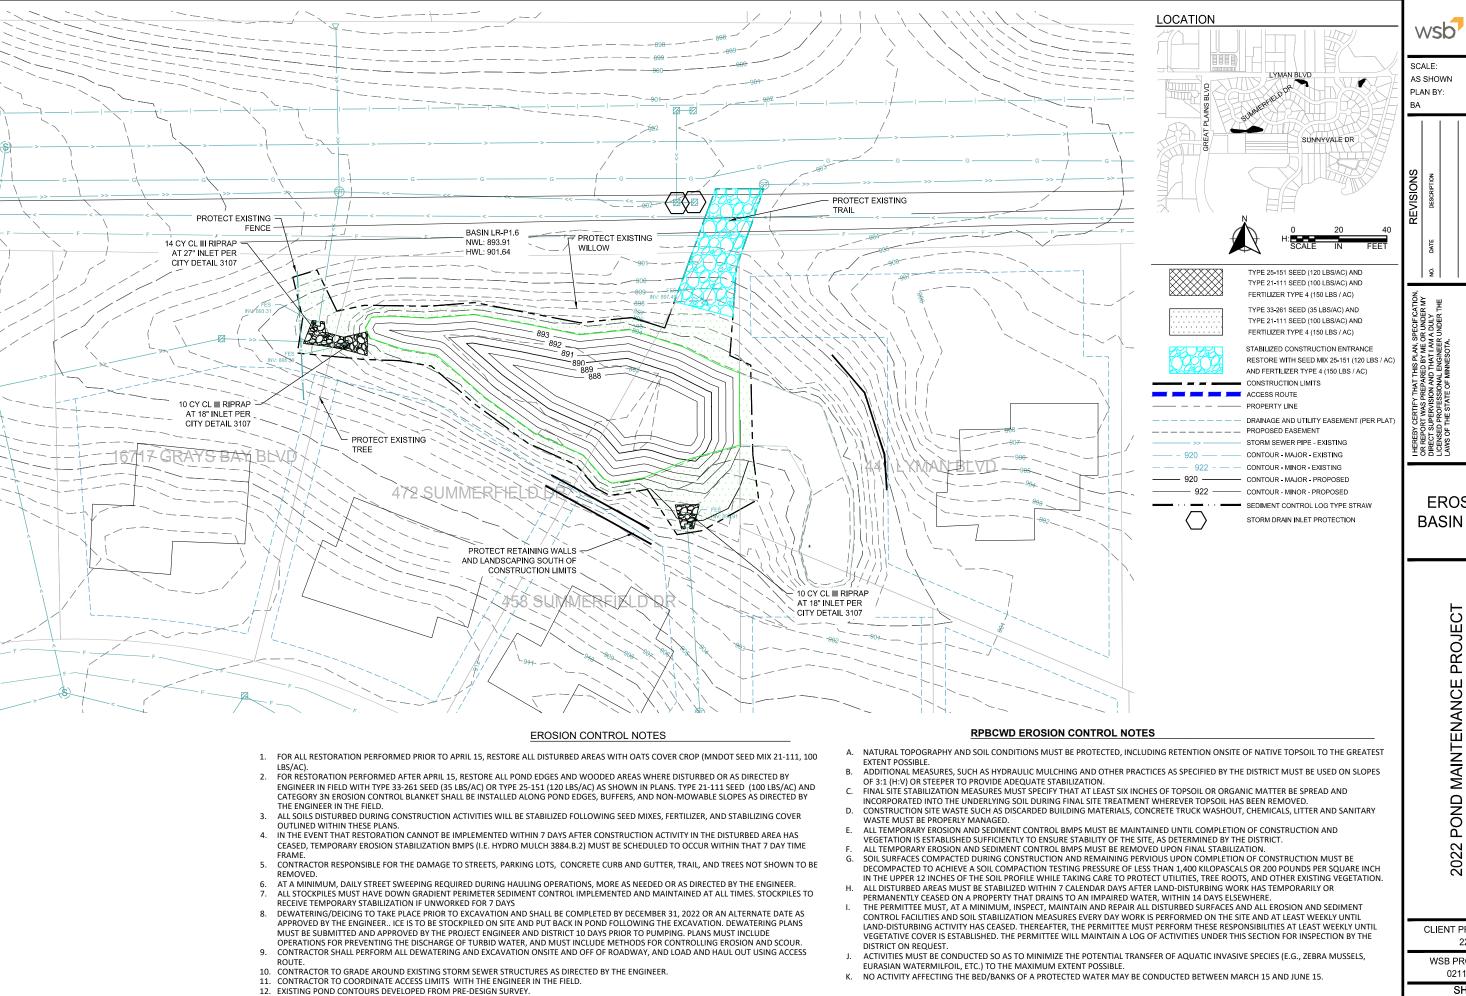BASIN LR-P1.6

CITY OF CHANHASSEN, MN

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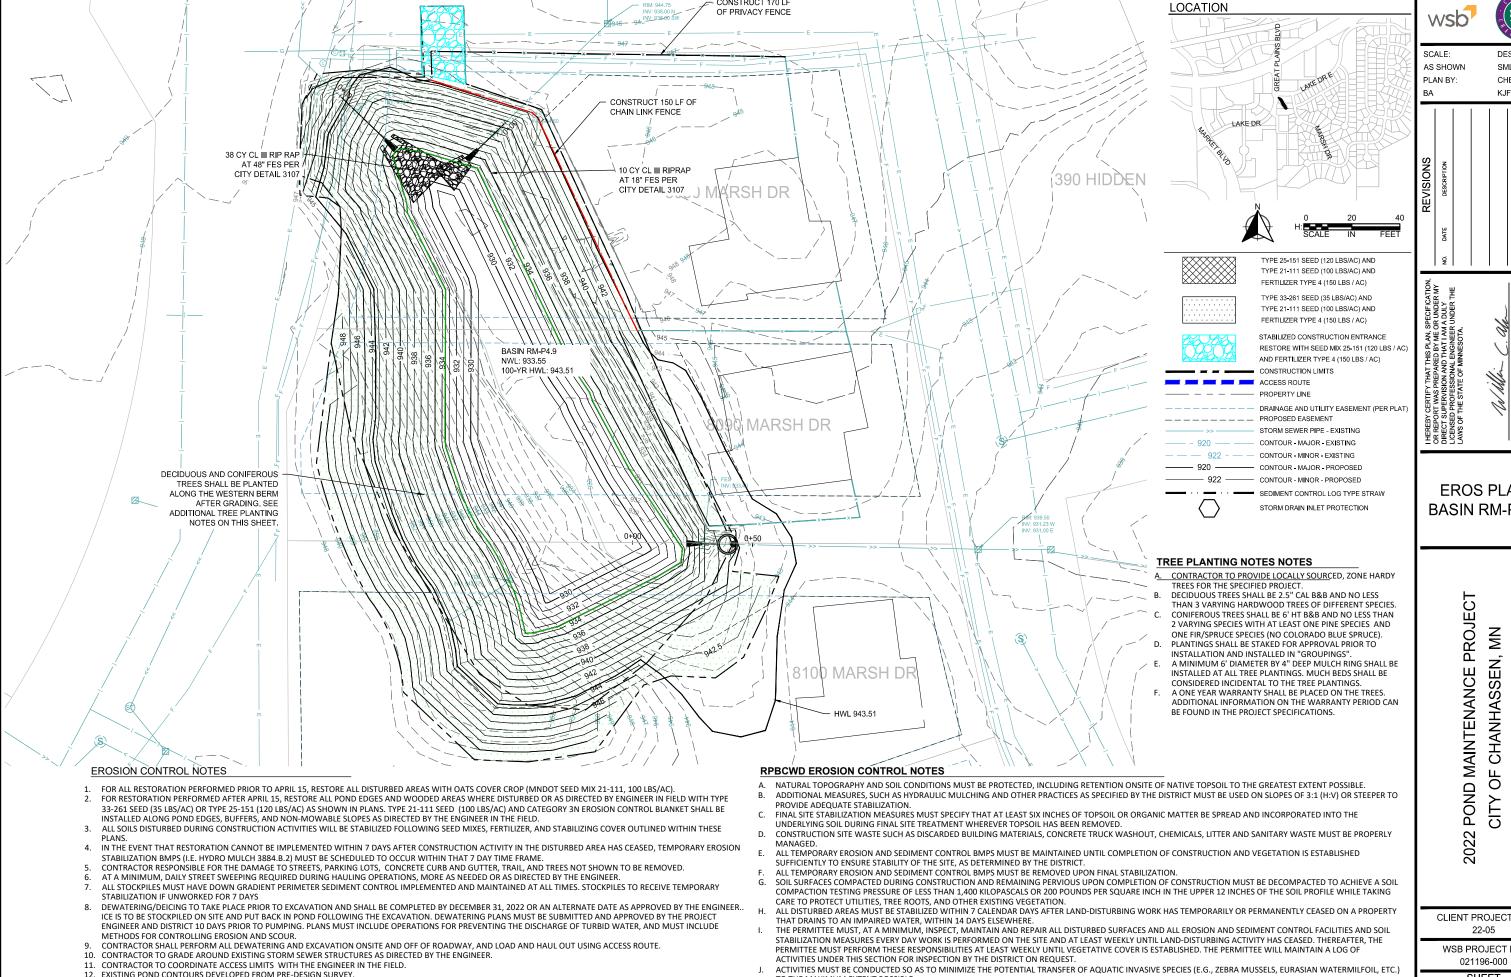
**EROS PLAN** BASIN LR-P1.7B

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SHEET



TO THE MAXIMUM EXTENT POSSIBLE.

NO ACTIVITY AFFECTING THE BED/BANKS OF A PROTECTED WATER MAY BE CONDUCTED BETWEEN MARCH 15 AND JUNE 15.

CONSTRUCT 170 LF

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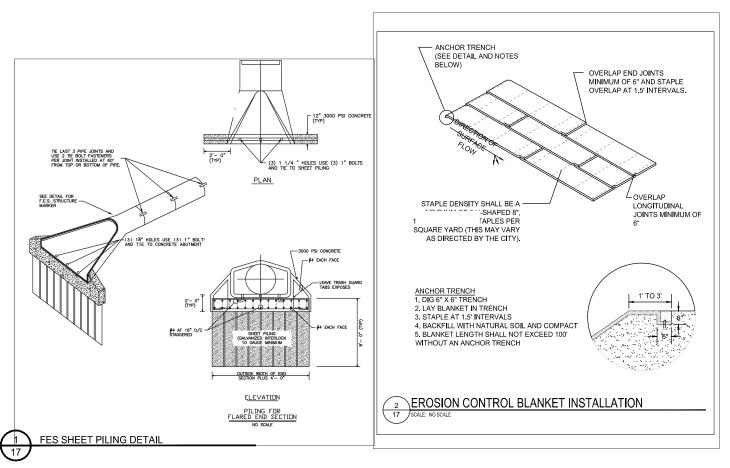
**EROS PLAN** 


BASIN RM-P4.9


CLIENT PROJECT NO

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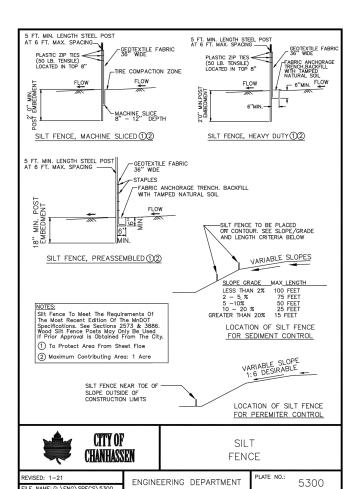
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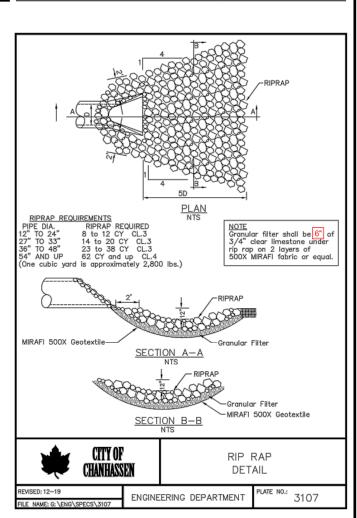




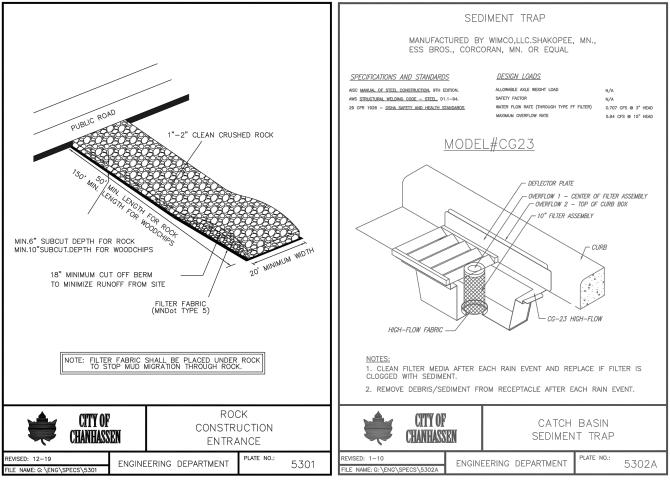

**DESIGN SPECIAL 1 STRUCTURE** 

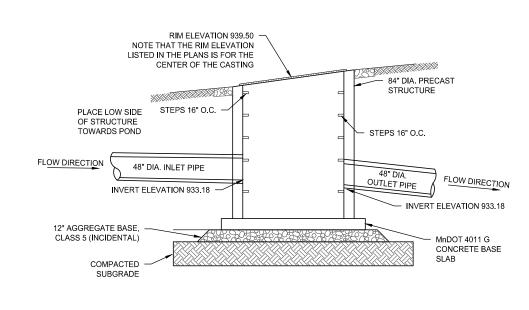





MISCELLANEOUS DETAILS

SCALE:

AS SHOWN

PLAN BY:

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KJF

CHECK BY:

# 2022 POND MAINTENANCE PROJECT CITY OF CHANHASSEN, MN

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SHEET 12 of 12